SILVA RESIDENCE

PROPOSED ADDITION

6 McNAMARA WAY FOXBORO, MA

AJA PROJECT NO. 21-AJA-20




AJA GROUP, INC.

16 MASON AVENUE SUITE 5 NORTH AT

16 MASON AVENUE, SUITE 5 NORTH ATTLEBORO, MA 02760 phone: (781) 935-2500 fax: (781) 935-2519





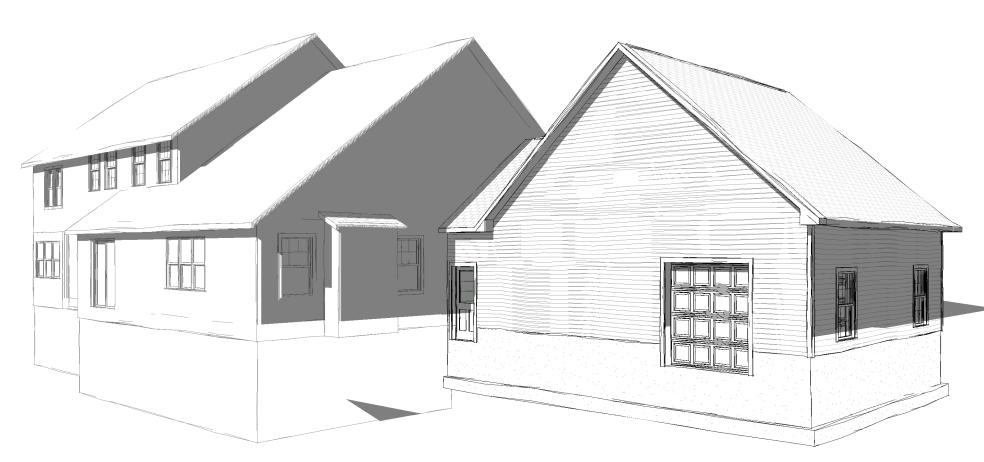

REAR

PROJECT LOCUS MAP

GENERAL NOTES

1 UNLESS OTHERWISE DIRECTED BY THE OWNER IN WRITING, THE WORK MUST BE CONDUCTED BETWEEN THE HOURS OF 8:00 A.M. AND 6:00 P.M. ON MONDAY THROUGH FRIDAY. NO WORK IS TO BE DONE ON HOLIDAYS, SATURDAYS OR SUNDAYS OTHER THAN FOR EMERGENCIES
2 ALL WORK SHALL COMPLY WITH THE COMMONWEALTH OF MASSACHUSETTS STATE BUILDING CODE, THE REQUIREMENTS OF THE FOXBORO,

THE OCCUPATIONAL SAFETY AND HEALTH STANDARDS AND ALL OTHER APPLICABLE REGULATIONS, LAWS, ORDINANCES, ETC. GOVERNING

- 1 HIS MORK.

 3 IT IS STRONGLY RECOMMENDED THAT ALL BIDDERS/CONTRACTORS INSPECT THE PROJECT TO VERIFY ALL EXISTING CONDITIONS. THE BIDDER/CONTRACTOR WILL BE HELD FULLY RESPONSIBLE FOR THE FULL EXTENT OF ALL MORK REQUIRED.
- BIDDER/CONTRACTOR WILL BE HELD FULLY RESPONSIBLE FOR THE FULL EXTENT OF ALL WORK REQUIRED.

 4 THE BIDDER/CONTRACTOR SHALL CONFIRM AND VERIFY IN THE FIELD ALL CONDITIONS, DIMENSIONS AND LOCATIONS PRIOR TO SUBMITTING THEIR BID. DRAWN INFORMATION IS TAKEN FROM EXISTING DRAWINGS AND RANDOM FIELD MEASUREMENTS AND IS PROVIDED ONLY TO ASSIST THE BIDDER/CONTRACTOR IN ESTABLISHING THE SCOPE OF WORK.
- THE BIDDER/CONTRACTOR SHALL REPORT IN WRITING ALL DEVIATIONS IN THE EXISTING CONDITIONS, DIMENSIONS AND LOCATIONS ETC. TO THE ARCHITECT. ACTUAL CONDITIONS MAY VARY FROM WHAT IS SHOWN ON THESE DRAWINGS.
- DO NOT SCALE DRAWINGS FOR QUANTITIES, LENGTHS, SIZES OR AREAS. ALL EXISTING DIMENSIONS SHOWN ARE APPROXIMATE AND SHALL BE VERIFIED BY CONTRACTOR IN THE FIELD.

 IT IS NOT INTENDED THAT THESE DRAWINGS SHOW EVERY CUT AND /OR CONDITION ETC. OF THE BUILDING SYSTEMS, HOWEVER THE

CONTRACTOR SHALL FURNISH A COMPLETE PRODUCT IN ACCORDANCE WITH THE BEST PRACTICE OF THE TRADE, TO THE SATISFACTION OF

- THE ARCHITECT AND IN STRICT CONFORMANCE WITH ALL APPLICABLE STATE AND LOCAL BUILDING CODE REQUIREMENTS.

 8 ALL MATERIALS AND NOTES REFER TO NEW MATERIALS UNLESS OTHERWISE NOTED OR INDICATED AS EXISTING.

 9 THE CONTRACTOR SHALL TEMORARILY DISCONNECT AND REMOVE ALL EXISTING SERVICES THAT INTERFER WITH THE PROPER INSTALLATION OF THE NEW CONSTRUCTION. CONTRACTOR IS RESPONSIBLE TO NOTIFY THE ARCHITECT/OWNER OF THESE SERVICES BEFORE DISCONNECTION. REINSTALL AND RECONNECT ALL TEMPORARILY DISCONNECT AND REMOVED ITEMS TO THE SATISFACTION OF THE
- 10 ALL EXISTING AREAS DISTURBED OR DAMAGED AS A RESULT OF THE NEW CONSTRUCTION ARE TO BE PATCHED OR REPLACED TO MATCH EXISTING AND /OR NEW ADJACENT SURFACES UNLESS NOTED OTHERWISE.
- 11 DISPOSE OF ALL DEBRIS IN A LEGAL MANNER.

SHEET LIST

NO. SHEET NAME

A-O COVER PAGE

A-1 ABBREVIATIONS AND SCHEDULES

(-2 FOUNDATION PLAN

4-3 PROPOSED FIRST FLOOR PLAN 4-4 FRONT & RIGHT SIDE ELEVATIONS

A-5 TYPICAL SECTIONS

A-6 FIRST FLOOR FRAMING PLAN

E-1 ELECTRICAL PLANS

DATE: 3/01/22

LOCUS PLAN & TITLE SHEET

A-0

ABBREVIATIONS

FOC

FOF

FOM

FOS

MEMBRANE

FACE OF CONCRETE


FACE OF MASONRY

FACE OF FINISH

FACE OF STUD FIRE PROOFING FIRE RETARDANT


FLUID APPLIED

FOOTING FURRING

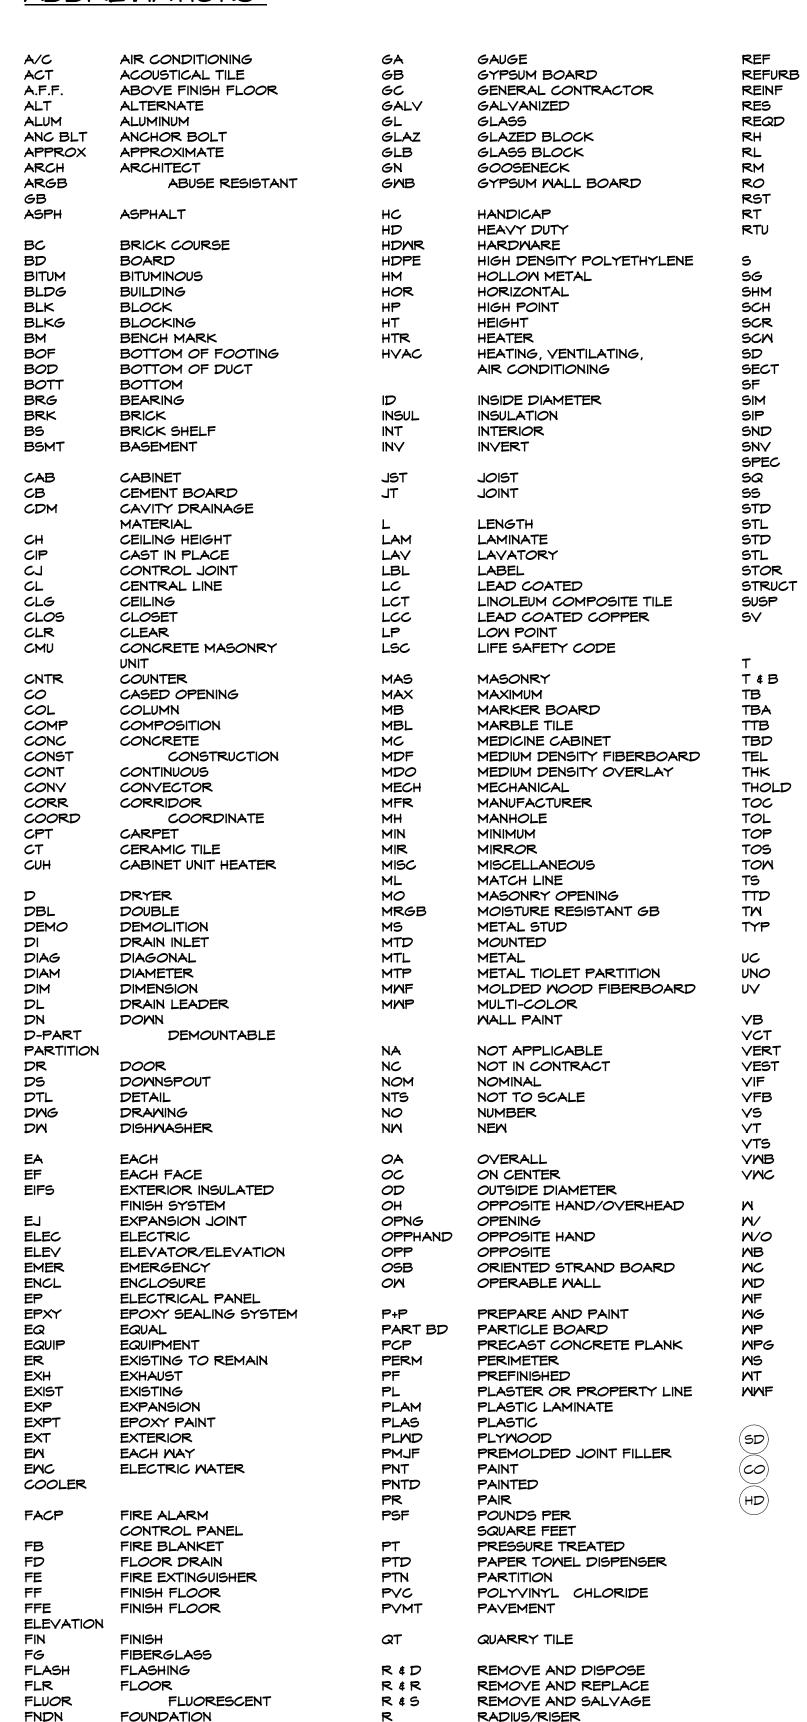

RUBBER MAT ROOF DRAIN

RD

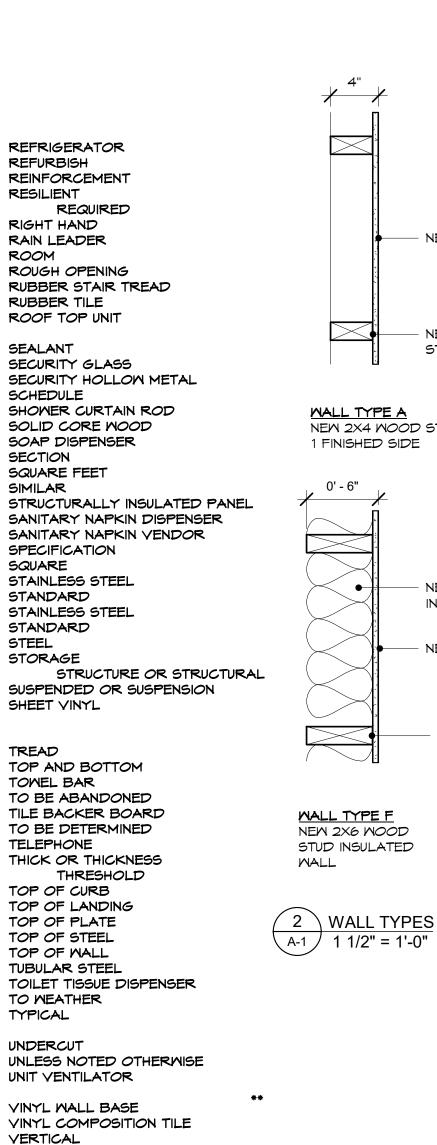

YESTIBULE

VENT-STACK

MASHER

MITHOUT

MOOD MIRE FABRIC

MITH

VINYL TREAD

VERIFY IN FIELD

VINYL WALL BASE

MATER CLOSET

MIRE GLASS

WALL PAPER

MOOD STUD

Smoke Detector

CO Detector

Heat Detector

MATER PROOF(ING)

MELDED WIRE FABRIC


YENEER PLASTER BASE

VINYL TRANSITION STRIP

VAINLY WALL COVERING

WRITING (WHITE) BOARD


| 4" | 0' - 4" | 4 1/2" | 4 1/2" | 6" |
|--|--|--|--|---|
| | NEW R-20 BATT INSULATION | | NEW R-20 BATT INSULATION | |
| NEW 1/2" GWB. P+P | NEW 1/2" GWB. P+P | NEW 1/2" GWB. P+P BOTH SIDES. | NEW 1/2" GWB. P+P BOTH SIDES. | NEW 1/2 GWB. P+P |
| NEW 2X4 WOOD STUDS @ 16" O.C. | NEW 2X4 WOOD STUDS @ 16" O.C. | NEW 2X4 WOOD STUDS @ 16" O.C. | NEW 2X4 MOOD STUDS @ 16" O.C. | NEW 2x6 WOOD STUDS 16" O.C. |
| ALL TYPE A EM 2X4 MOOD STUD MALL FINISHED SIDE | MALL TYPE B NEW 2X4 WOOD STUD MALL INSULATED MALL | MALL TYPE C NEW 2X4 MOOD STUD INSULATED MALL | MALL TYPE D NEM 2X4 MOOD STUD INSULATED MALL | MALL TYPE E NEW 2X6 MOOD STUD INSULATED WALL |
| 0' - 6" | 0' - 6 1/2" | 0' - 6 1/2" | 7 5/8" NEW WEATHER | 7 5/8" NEW MEATHER |

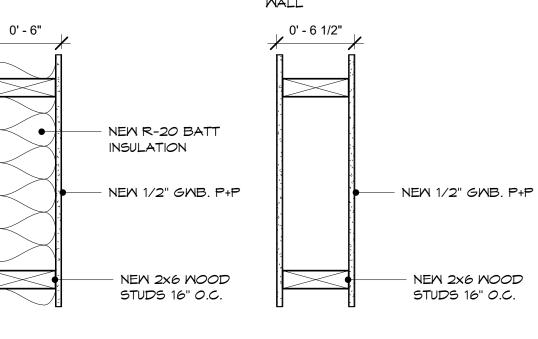

MALL TYPE G

NEW 2X6 WALL


2 FINISHED SIDES

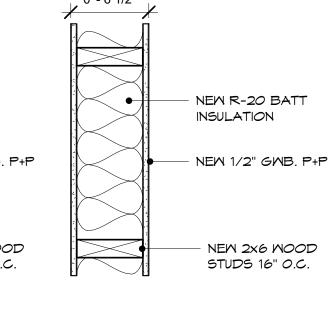

MALL TYPE H


2 FINISHED SIDES

NEW 2X6 INSULATED WALL

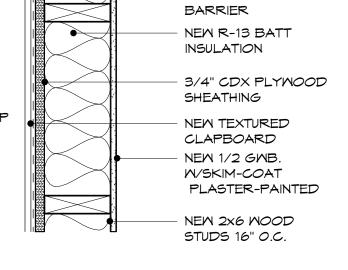

NEW 2X6 EXTERIOR INSULATED


CLAPBOARD SIDING

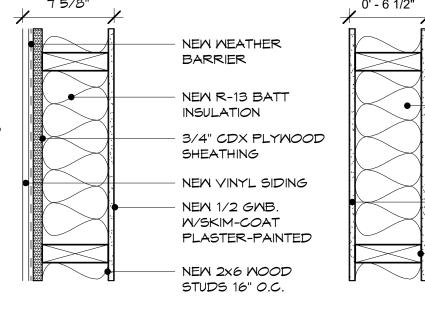

MALL TYPE J

VINYL SIDING

NEW 2X6 EXTERIOR INSULATED

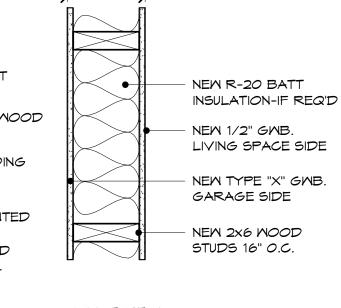

| | LIVING SPACE SIDE |
|-----------------------------|---------------------------------|
| | NEW TYPE "X" GMB GARAGE SIDE |
| | NEW 2x6 WOOD STUDS 16" O.C. |
| MALL TYPE X NEM 2X6 MALL | |

INSULATED IF REQUIRED INT. FINISH SIDE 5/8" GMB GARAGE FINISH SIDE TYPE "X" GMB

| | | | D00F | R SCHEDULE | * |
|------|-------|----------|---------|------------|-----------|
| TYPE | COUNT | MIDTH | HEIGHT | MATERIAL | DOOR TYPE |
| | | | | | |
| 001 | 4 | 3' - 0" | 6' - 8" | | |
| 002 | 2 | 3' - 0" | 6' - 8" | | |
| 003 | 1 | 2' - 8" | 6' - 8" | | |
| 004 | 16 | 2' - 6" | 6' - 8" | | |
| 005 | 1 | 6' - 0" | 6' - 8" | | |
| 006 | 2 | 10' - 0" | 7' - 6" | | |
| 007 | 1 | 7' - 0" | 7' - 6" | | |

| MINDOM SCHEDULE | | | | | | |
|-----------------|-------------|--------------|--------------|---------|--|--|
| MARK | ROUGH MIDTH | ROUGH HEIGHT | MANUFACTURER | MODEL | | |
| A | 2' - 10" | 4' - 9 1/2" | HARVEY BP | 2846 | | |
| В | 2' - 6" | 3' - 5 1/2" | HARVEY BP | 2432 | | |
| C | 5' - 9 1/4" | 5' - 1 1/2" | HARVEY BP | 29410-2 | | |

DATE:

SCALE:

DRAWN BY: R.M.D.

architects

PROJECT #: 21-AJA-20

3/01/22


935-2500

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2

As indicated

A-1

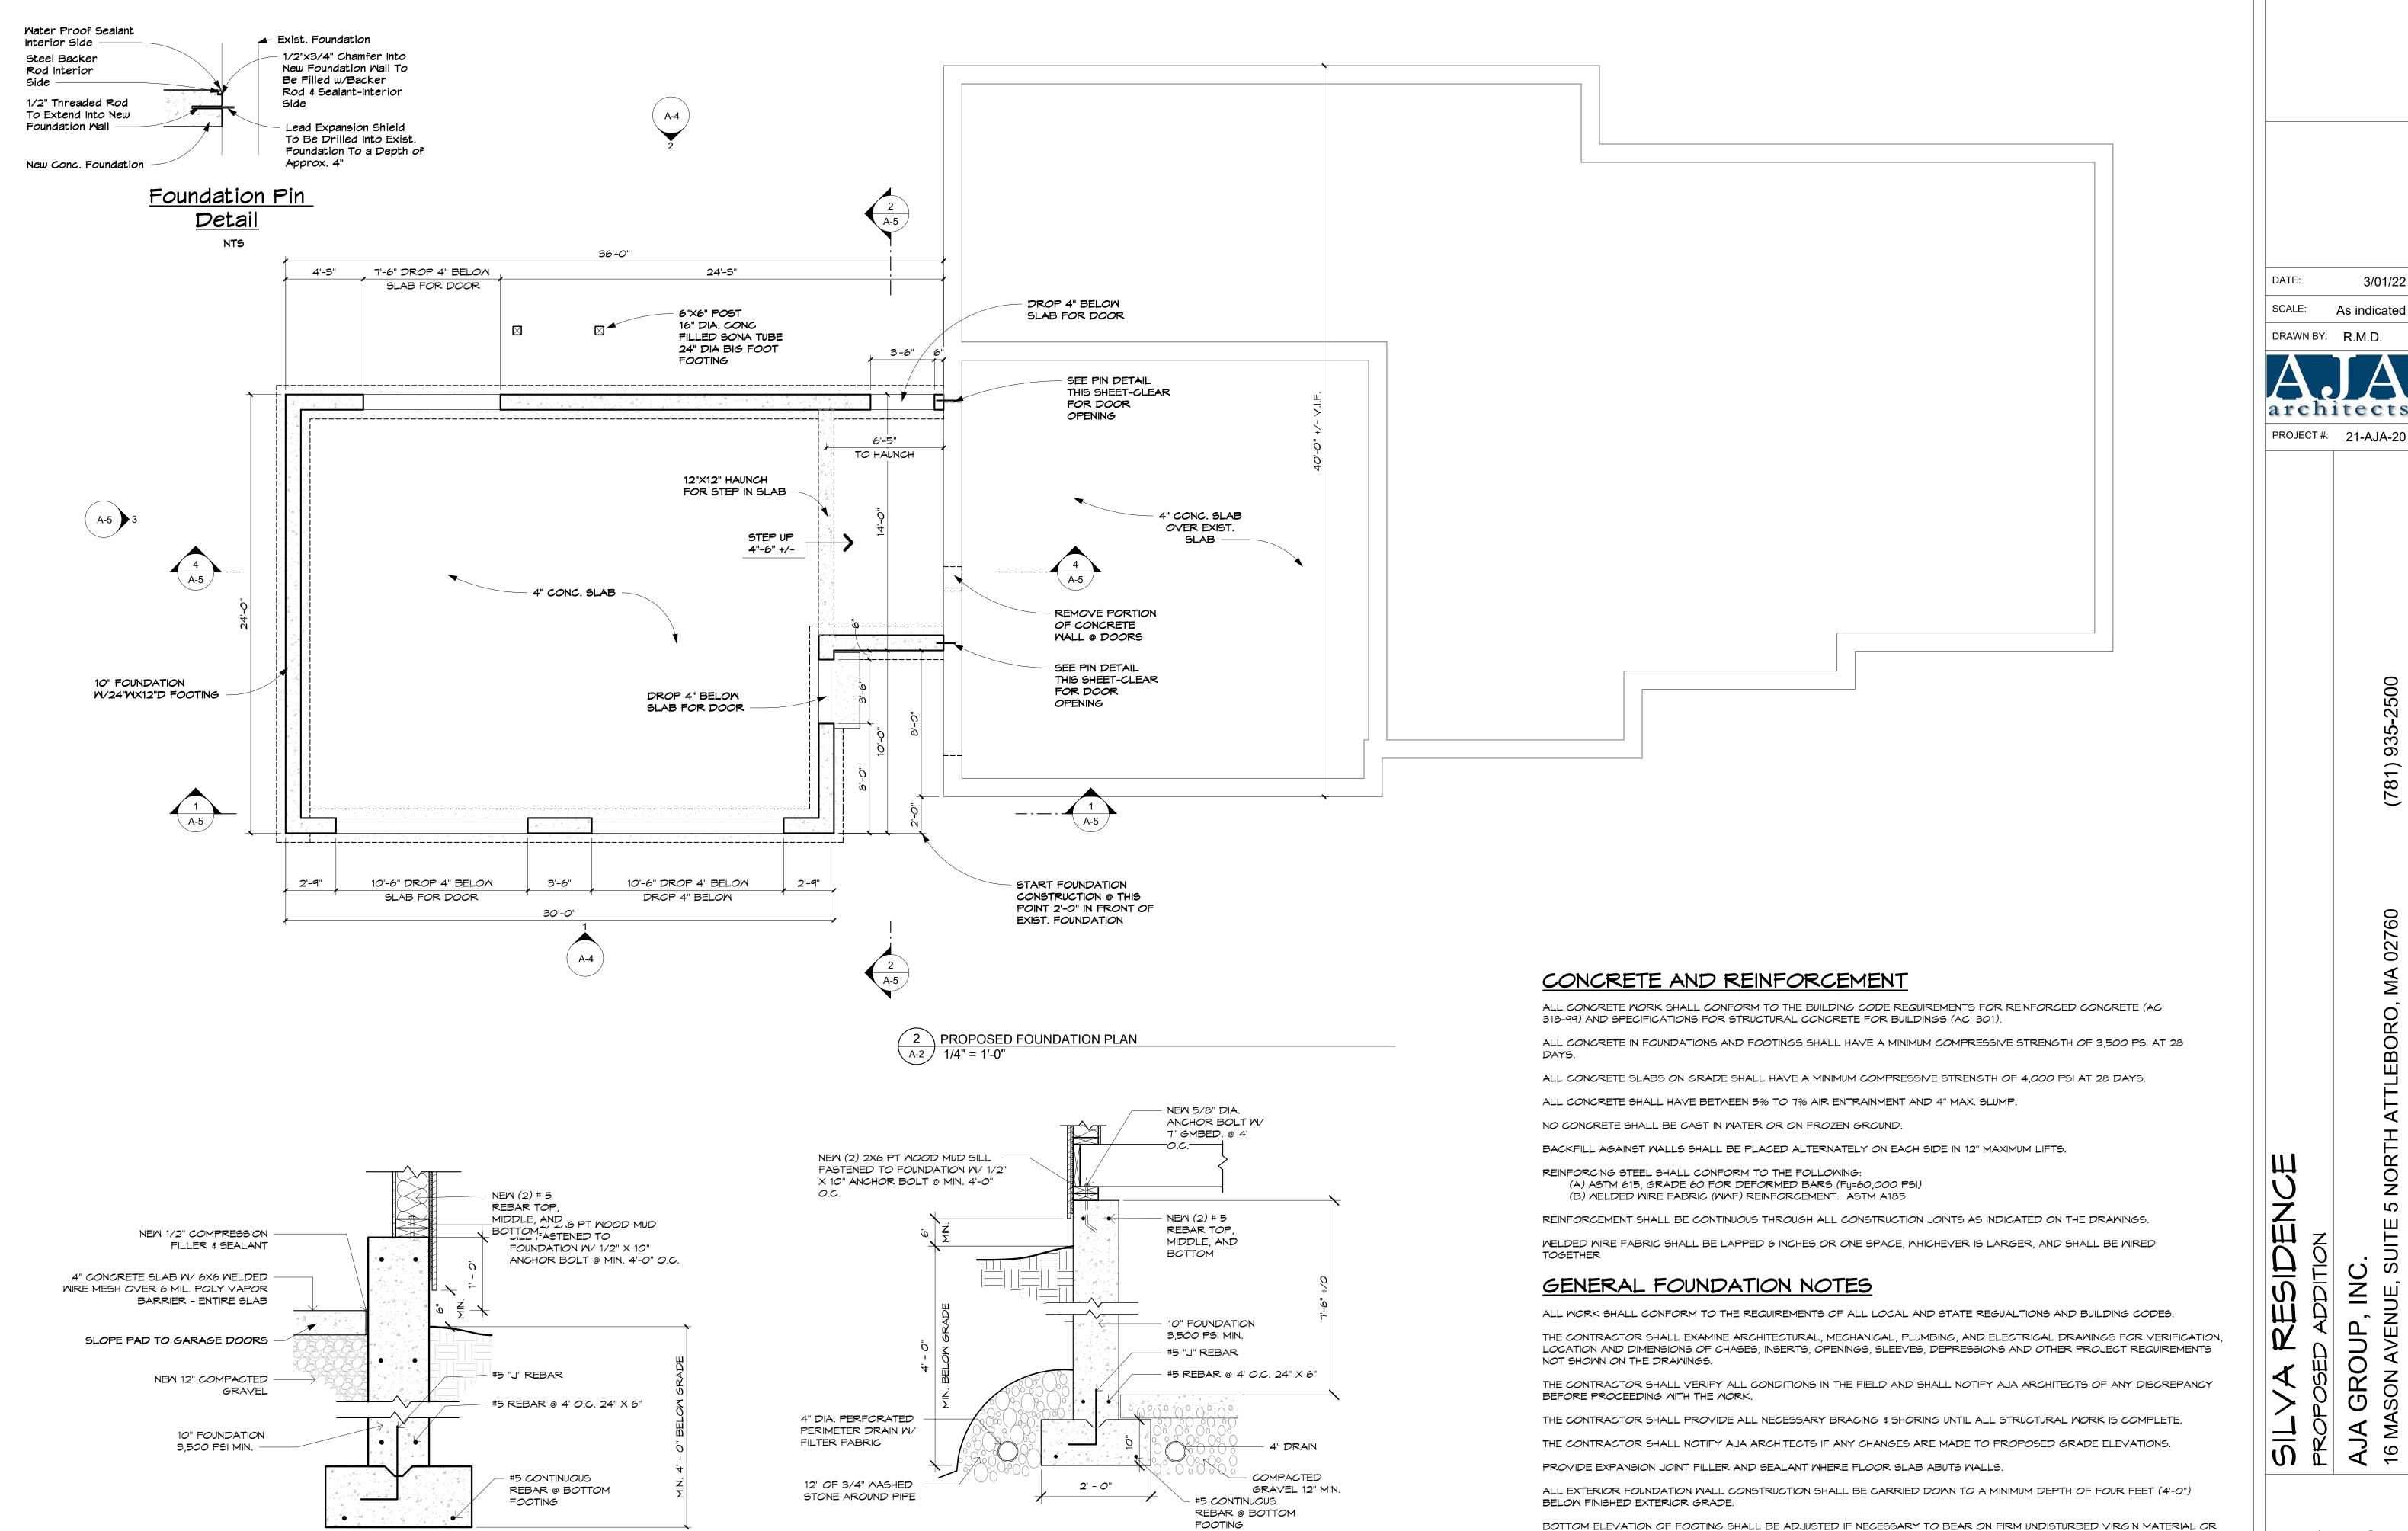


3 TYP. FOUNDATION DETAIL

1 TYP. FOUNDATION @ GARAGE

ENGINEERED FILL CAPABLE OF SUPPORTING A MIN. SOIL BEARING CAPACITY OF 2,500 PSF. FOUNDATION PLAN

3/01/22

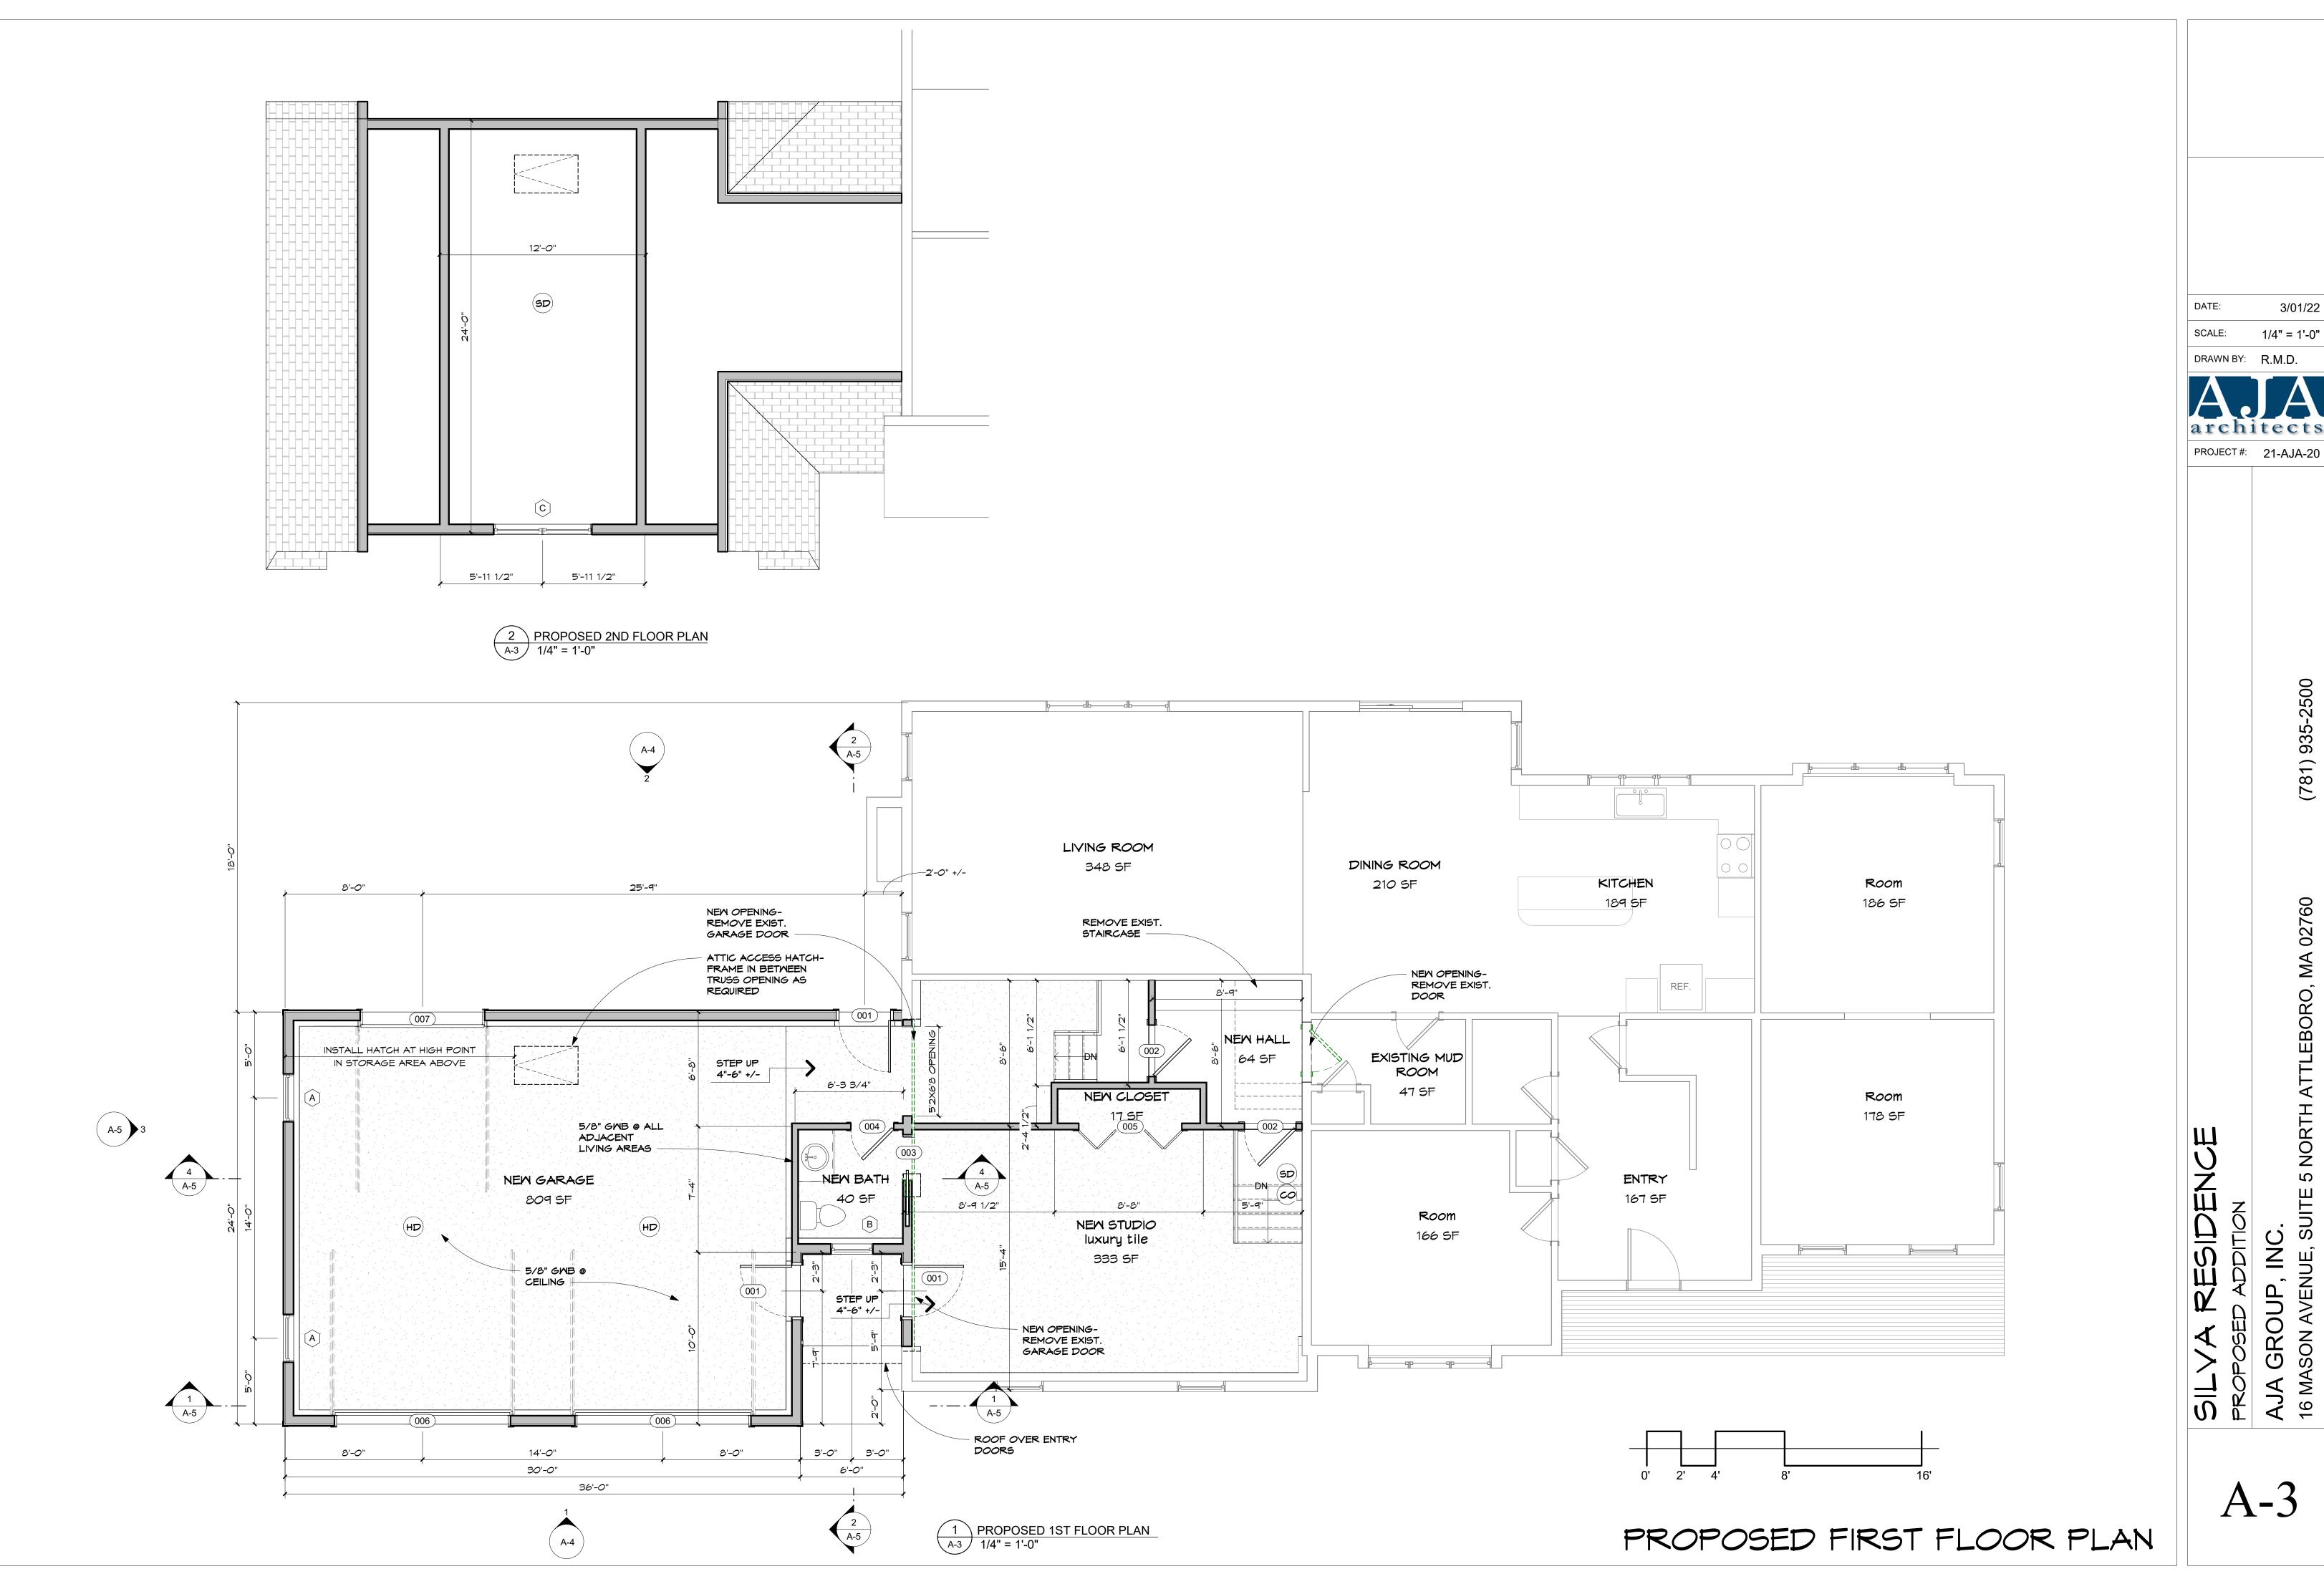


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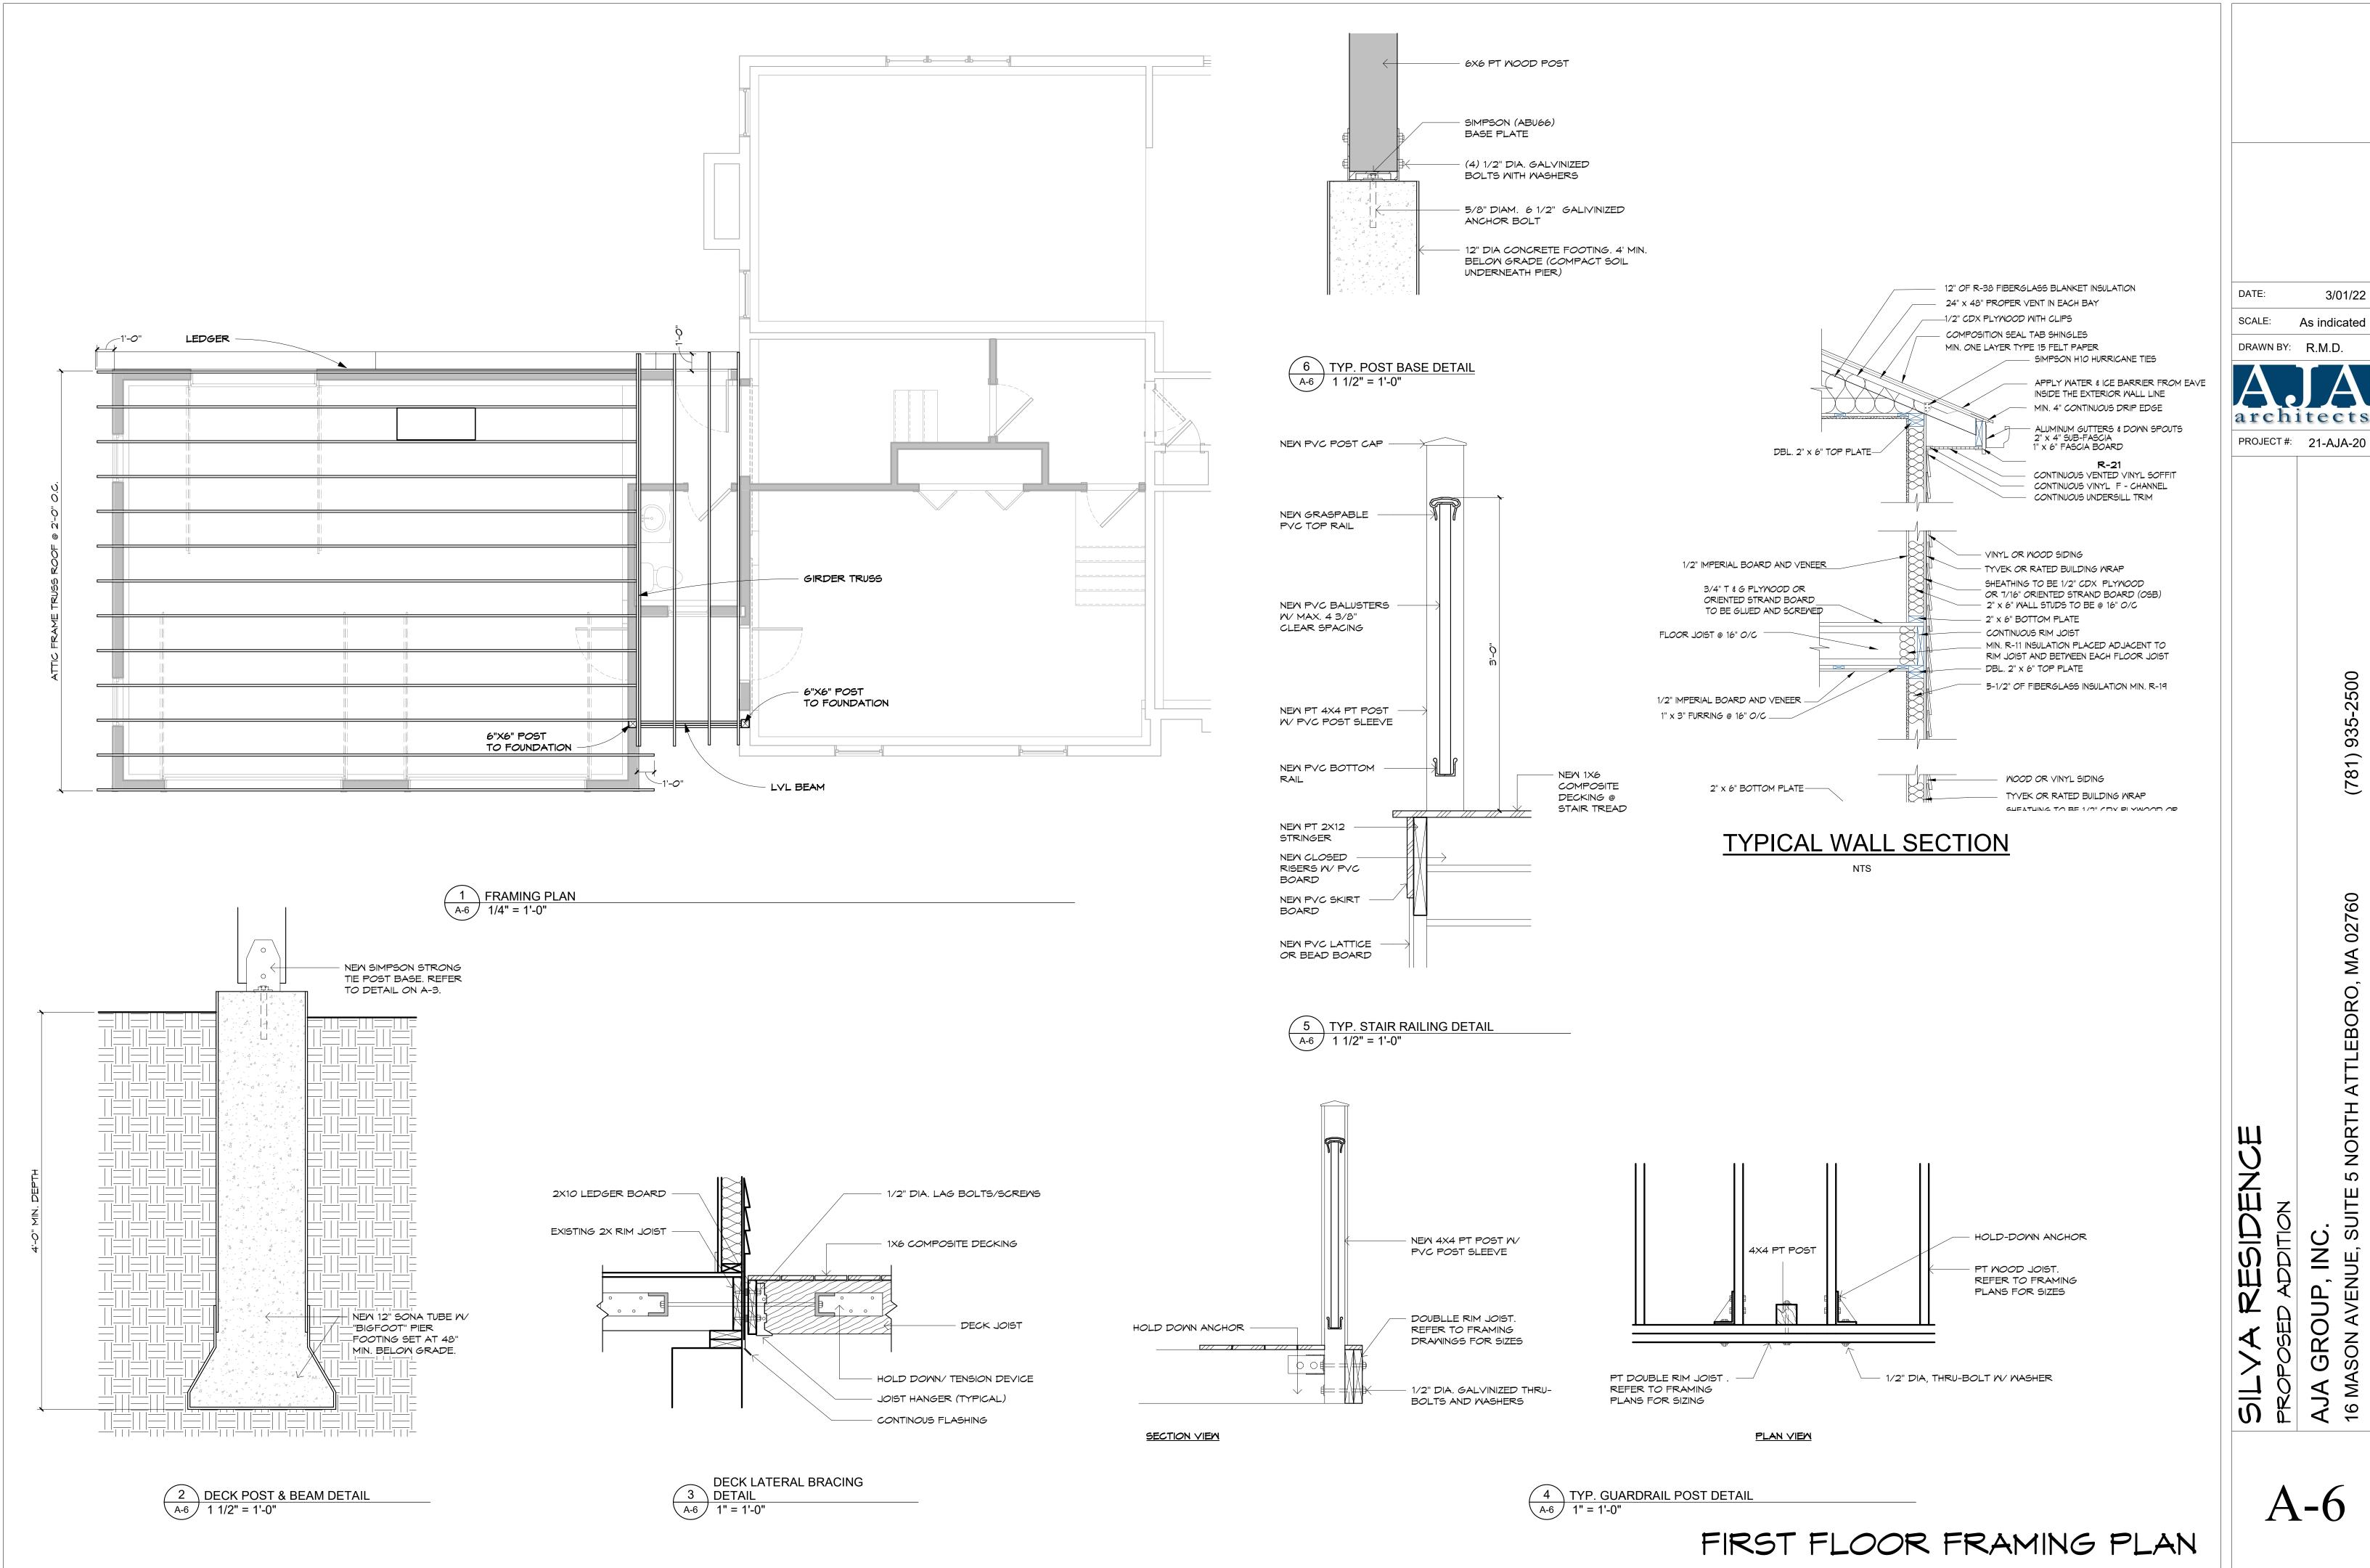
1/4" = 1'-0"



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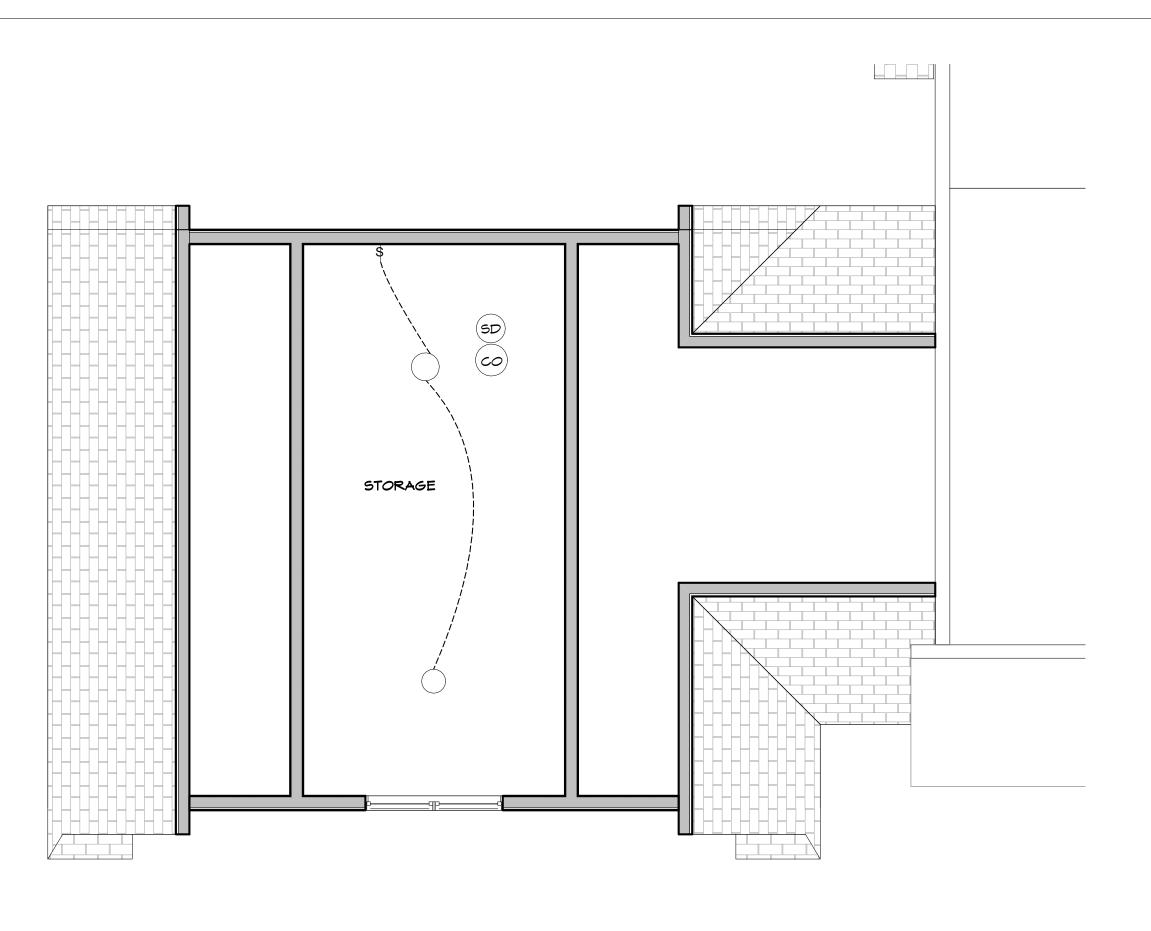
(781) 935-2500

1/4" = 1'-0"

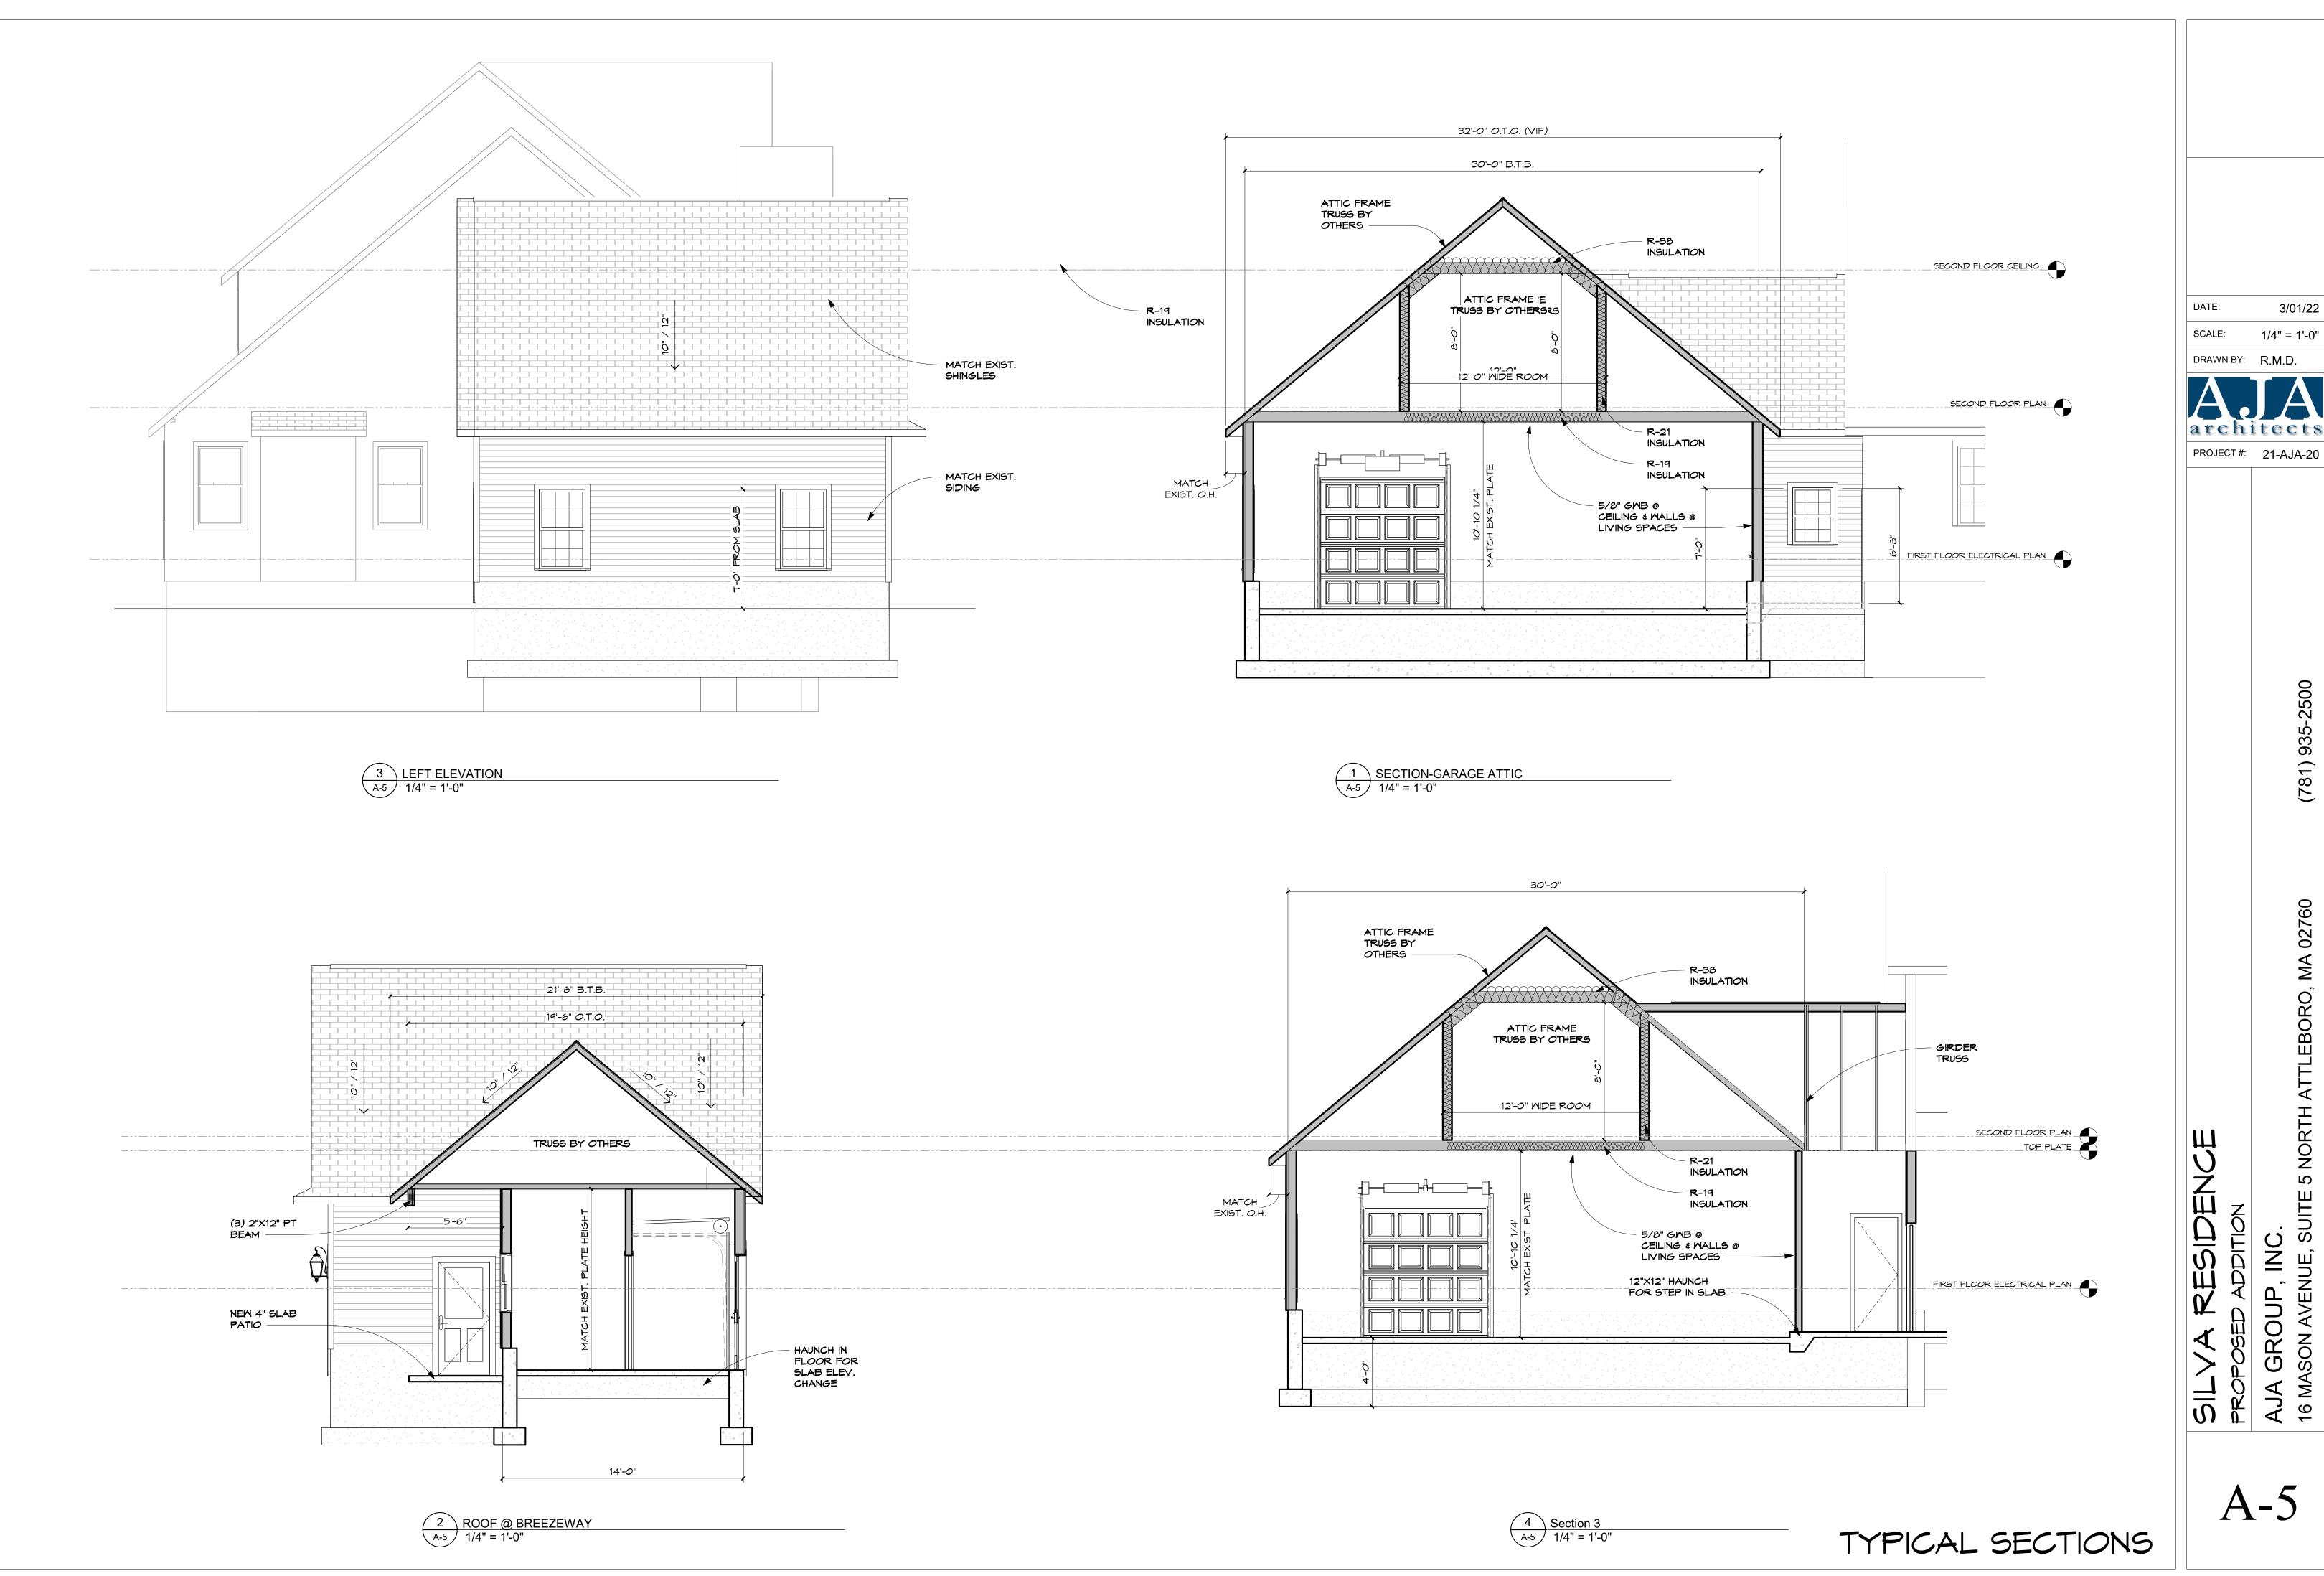


3/01/22

As indicated



SECOND FLOOR ELECTRICAL
PLAN
E-1 1/4" = 1'-0"

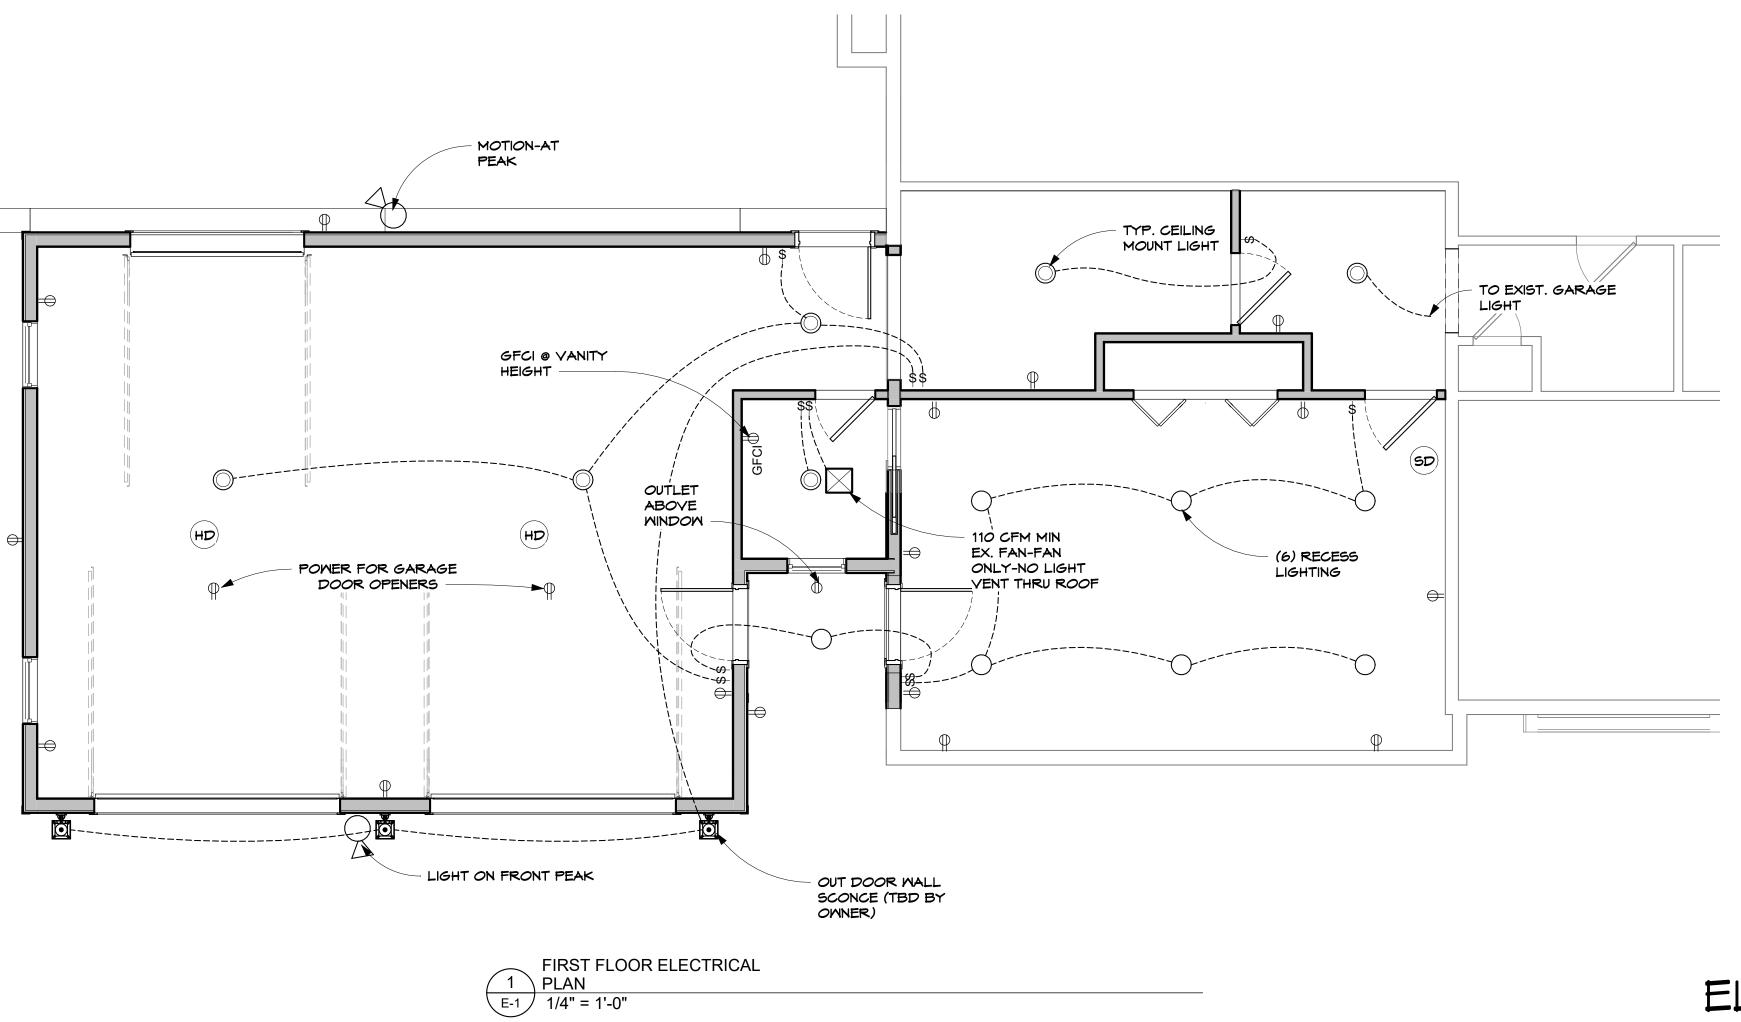

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ELECTRICAL PLANS